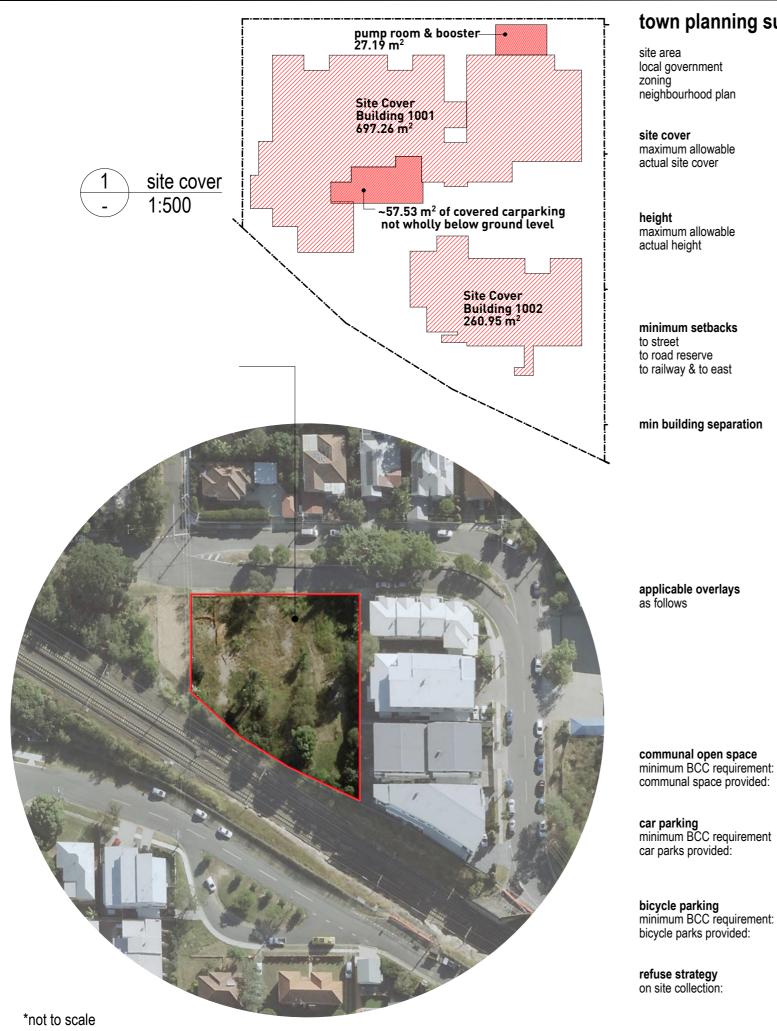


	title:	rev:
00	cover sheet & drawing schedule	F
01	local context plan & notes	F
01	existing site / demolition	E
02	site circulation plans	E
03	site setout plan	С
01	basement / site plan	E
02	ground floor / site plan	E
03	level 1 floor plan	E
04	level 2 floor plan	E
05	roof plan	E
06	typical unit plans	D
01	north & east elevations	E
02	south & west elevations	E
01	sections 1 & 2	E
02	sections 3 & 4	E
01	3D view	С

in-r	recycle bin
in-w	waste bin
ol	column
ng	engineer
xg	existing
l	finished flo
sl	finished sla
N	floor waste
d	grated drai
r	grab rail
dg	hot dip galv
nax	maximum
nin	minimum
nsb	main switch
gl	natural gro
om	nominal
S	stainless st
C	to be confir
W	top of wall I
gsi	tactile indic
no	unless note
/C	water close



# town planning summary:

site area local government neighbourhood plan

site cover maximum allowable actual site cover

maximum allowable actual height

minimum setbacks to street to road reserve to railway & to east

### min building separation

Brisbane City Council LMR2 - Low Medium Density Residential (2 or 3 Storey M Ashgrove-Grange District Neighbourhood Plan

45% 44% excluding covered carparking not wholly below groun 48% including covered carparking not wholly below groun (refer adjacent diagram)

3 Storeys Max / 11.5m to the highest point 3 Storeys (under BCC definition) & 11.4m (approx) at high (underground carpark not counted as a storey where ceili

Note: although the design has 3 storeys under town plann Rise in Storeys of '4' based on definition in BCA Part C1.2

Front Setback:4m to Balcony / 6m to WallSecondary Street:3m to Balcony / 4m to Wall up to 3 stoSide Setbacks:2m up to 7.5m / 2.5m up to 10.5m / 3m \*eaves & sunhoods may encroach into \*relevant setbacks shown in red in dra

2 storeys up to 7.5m:

- Facing habitable rooms or balconies: 9m
- Habitable Rooms or balconies facing non-habitable room

- Non-habitable rooms or blank walls: 3m

2170sqm

3 to 5 storeys: - Facing habitable rooms or balconies: 12m

- Habitable Rooms or balconies facing non-habitable room

- Non-habitable rooms or blank walls: 6m

Airport Environs Overlay Bicycle Network Overlay Critical Infrastructure & Movement Network Overlay Heritage Overlay (N/A\_for railway) Road Hierarchy Overlay Streetscape Hierarchy Overlay Transport Noise Corridor Overlay Queensland Rail Corridor Koala SPP

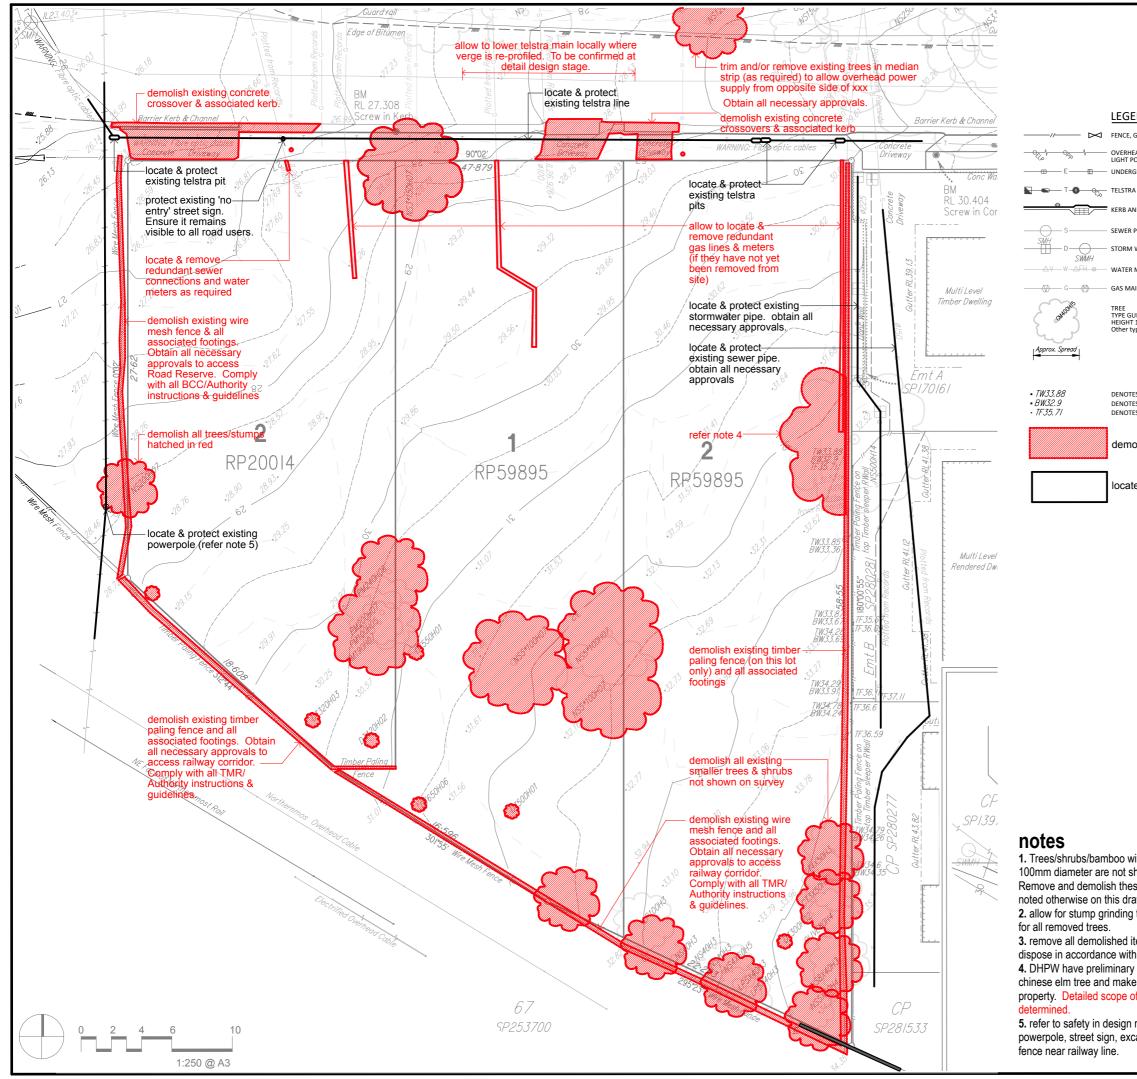
108.5sqm (5% of 2170sqm) including 25% internal space. approx 115sqm external space (no internal space provide

25 carparks 20 carparks (16 Covered / 1 Uncovered / 3 Partially Uncov Meets 20 required under SHDG.


27 bicycle parks (inc. 6 visitor) 15 provided. Meets 13 required under SHDG.

2 x 1100L Waste (Collected Weekly) 1 x 1100L Recycling (Collected Weekly) 1 x 240L Waste (Collected Weekly) 1 x 240L Recycle (Collected Weekly or Fortnightly) Based on email dated 05/09/19 from BCC WaRRS and ra


/lix)	AMENDMENTS ISSUE DATE SUBJECT F 28.06.21 100% SD (FC DRAWING INDEX SYSTEN FOR BUILDING and ASSET SERVICES	Λ	W)	AUTHORISED ML
nd, pump & booster nd, pump & booster	CEILING PLANS CONSTRUCTION DETAILS ELEVATIONS EXTERNAL WORKS FITOUTS FLOOR PLANS FURNITURE & EQUIPMENT HYDRAULICS MASTER PLAN	MISCELLA OTHER PLAY STR ROOF PLA SECTIONS SETOUT P SITE PLAN STANDARI	UCTURES ANS S PLAN	TAILS
hest point ing <1m above NGL) ning definition, it has a 2		eensl vernm Public	nent	
oreys m up to 11.5m height to setbacks awings				
ms or blank walls: 6m				
ms or blank walls: 9m	SCHEMATIC DESIGN STAGE DRAWING IS INDICATIVE ONLY - CONTRACTOR/CONSULTANT TO VERIFY SITE CONDITIONS SHOWN ON THIS DRAWING WITH CONTOUR AND DETAIL SURVEY AND ACTUAL SITE CONDITIONS			_
	LADA DRAWN LADA	DRAFTING CH	IECK	
	DESIGN ML DISCIPLINE TEAM LEADER	DESIGN VERIF		
			CINI	<u> </u>
ed)	19/20 SOCIAL PROGRAM		SIN	G
overed).	1 x 3 BED UNIT (PLATINUM) 3 x 2 BED UNITS (1xPLAT / 2xGOLD) 16 x 1 BED UNITS (12xGOLD / 4xGEN)			
	LOCAL CONT NOTES		PLAN	√&
	NOT TO SCALE			E NUMBER
ates in SHDG	DRAWING NUMBER 86664 / SD / A00.	01	ISSUE	SHEET NO



	AMENDMENTS	AUTHORISE
SEND	E 28.06.21 100% SD (F	
E, GATE	DRAWING INDEX SYSTE FOR BUILDING and ASSET SERVICES	
HEAD ELECTRICITY, FPOLE, POWER POLE	CEILING PLANS	☐ MISCELLANEOUS DETAILS
RGROUND ELECTRICITY, PIT, BOX	CONSTRUCTION DETAILS     ELEVATIONS	OTHER     PLAY STRUCTURES
RA CABLE, MANHOLE, PIT, BOX, POLE	EXTERNAL WORKS     FITOUTS	ROOF PLANS     SECTIONS
AND CHANNEL, SIGN, GULLY TRAP	FLOOR PLANS     FURNITURE & EQUIPMENT	SETOUT PLAN SITE PLAN
R PIPE, MANHOLE	HYDRAULICS     MASTER PLAN	□ STANDARDS
M WATER PIPE, FIELD INLET, MANHOLE		
ER MAIN, VALVE, HYDRANT, METER	W AND MAN	
MAIN, VALVE, METER		eensland
, ,	GO	vernment
GUM TREE, TRUNK DIAMETER 400mm HT 15metres	Department of	
r types: CT = Citrus Tree DT = Dead Tree FG = Fig	Housing and	Public Works
GM = Gum LP = Lillypilly		
PB = Paper Bark PM = Palm		
NS = Not specified DTES RL AT TOP OF WALL		
DTES RL AT BOTTOM OF WALL DTES RL AT TOP OF FENCE		
nolish & remove from site		
ate & protect		
	SCHEMATIC DESIGN S	
	DRAWING IS INDICATI	
	SITE CONDITIONS SH	
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	PROGRAM	
with trunks smaller than		
shown on this drawing.	1 x 3 BED UNIT (PLAT	
ese small trees unless	3 x 2 BED UNITS (1xF 16 x 1 BED UNITS (12	
lrawings Ig to below ground level		
ig to below ground level	<b>EXISTING SIT</b>	ſE/
l items from site and	DEMOLITION	
ith specification.		
ry approval to remove ke good neighbour's	SCALE 1:250	A3 SIZE
of works to be	MASTER SITE NUMBER	CLIENT REFERENCE NUMBER
n report in relation to		86664
n report in relation to xcavation and removal of	DRAWING NUMBER	ISSUE SHEET N
	86664 / SD / A01	01

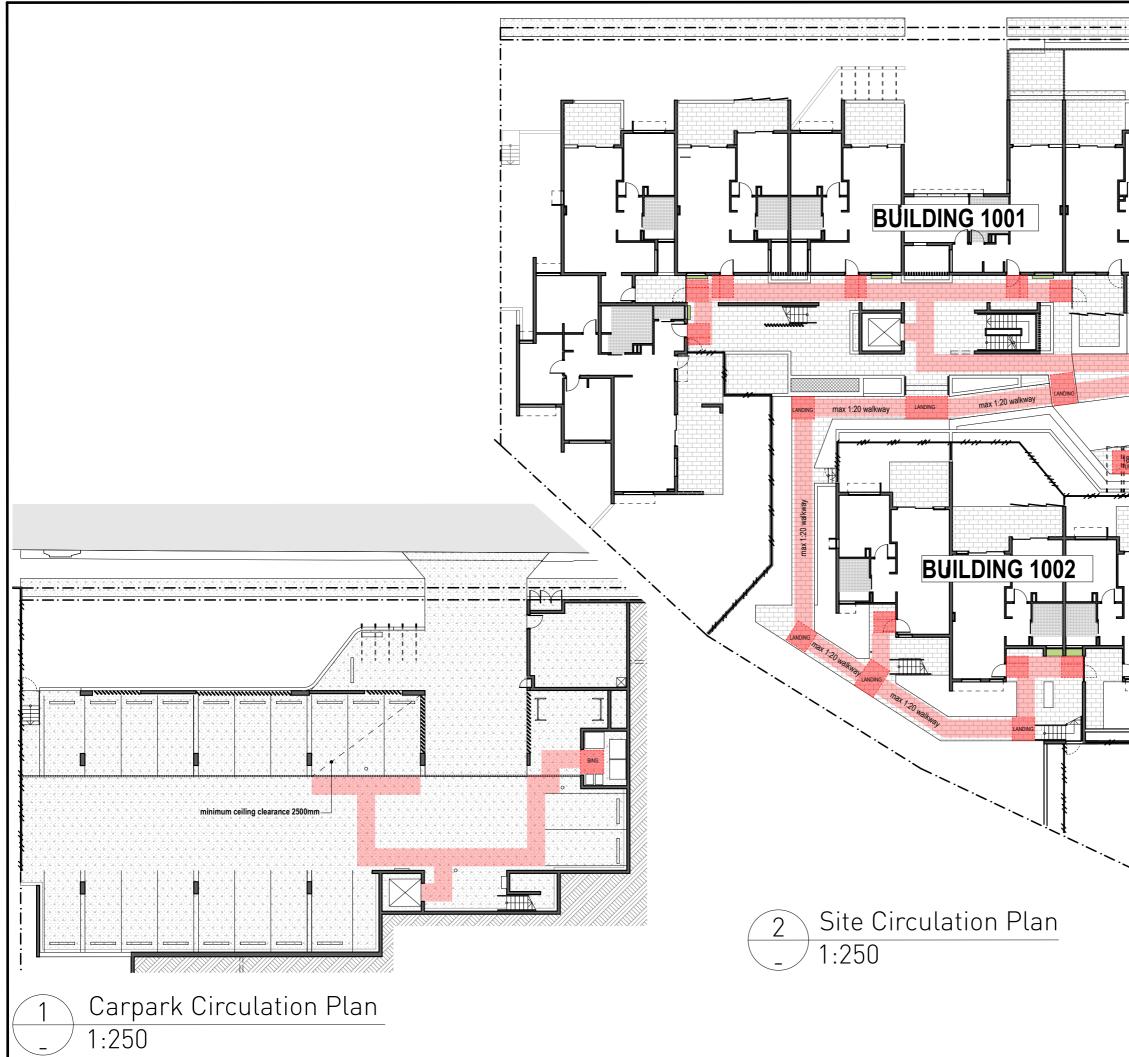


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max 1:20 walkway	FOR BUILDING and ASSET SERVICE CELLING PLANS CONSTRUCTION DETAILS ELEVATIONS EXTERNAL WORKS FITOUTS FLOOR PLANS FURNITURE & EQUIPMENT HYDRAULICS MASTER PLAN	S USE ONLY	
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<u>→</u>	LADA DESIGN	DESIGN VERIFICATI	ON
	ML DISCIPLINE TEAM LEADER	28/06/21 DATE	
	AUTHORISED FOR ISSUE	DATE	
	19/20 SOCIAI PROGRAM	L HOUSI	NG
, , ,	F       28.06.21       100% SD (FOR REVIEW)       ML         DRAWING INDEX SYSTEM POR BUILDING and ASSET SERVICES USE ONLY       Image: Construction betails Construction betails Construction betails Constructions       Image: Construction betails Construction betails Constructions         Extremal works       Conformation Constructions       Image: Construction betails Constructions       Image: Construction betails Constructions         Extremal works       Constructions       Seriours Constructions       Seriours Constructions         Extremal works       Seriours Constructions       Seriours Constructions         Extremal works       Seriours Constructions       Seriours Constructions         Extremal works       Seriours Constructions       Seriours Constructions         Image: Constructions       Department of Housing and Public Works         Department of Housing in Dicative Only - Constructore/Consultant To Verify Site Constructions Shown on this Drawing with contour and Detail Survey and actual site constructions         LADA Design       Design Verification         ML       28/06/21 Diccipline team Leader       Date         19/20 SOCCIAL HOUSING       Date		
	SITE CIRCUL	ATION P	LANS
			IZE
	MASTER SITE NUMBER		ENCE NUMBER
			UE SHEET NO

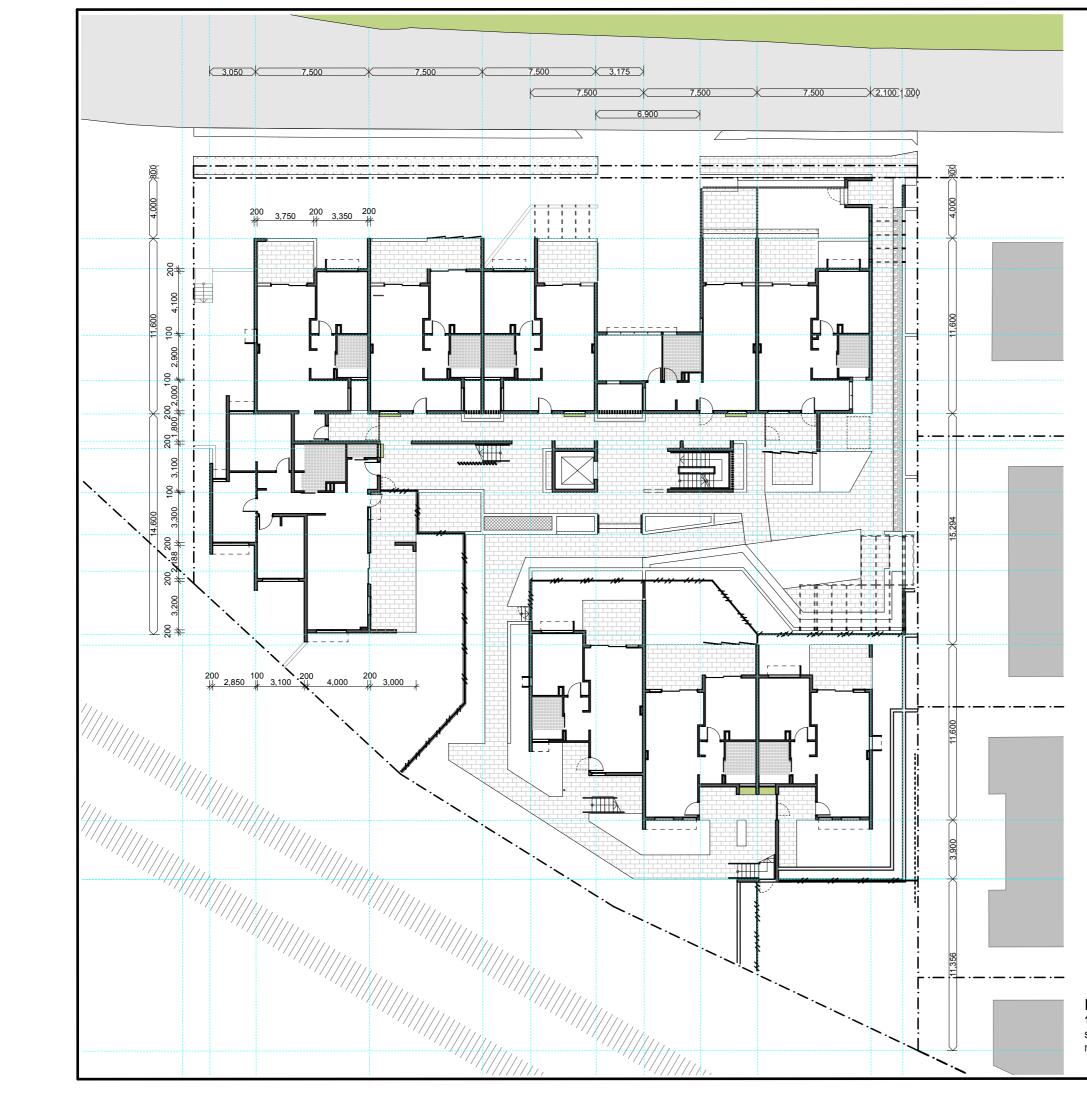


**notes** 1. Verify width of all walls to comply with NCC, structural, acoustic, energy efficiency & other requirements. Adjust building design accordingly.


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	AUTHORISED FOR ISSUE	DATE
	19/20 SOCIAI PROGRAM	- HOUSING
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	SITE SETOUT	ΓPLAN
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CC.	MASTER SITE NUMBER	CLIENT REFERENCE NUMBER
er dingly.	DRAWING NUMBER 86664 / SD / A01	ISSUE SHEET NO

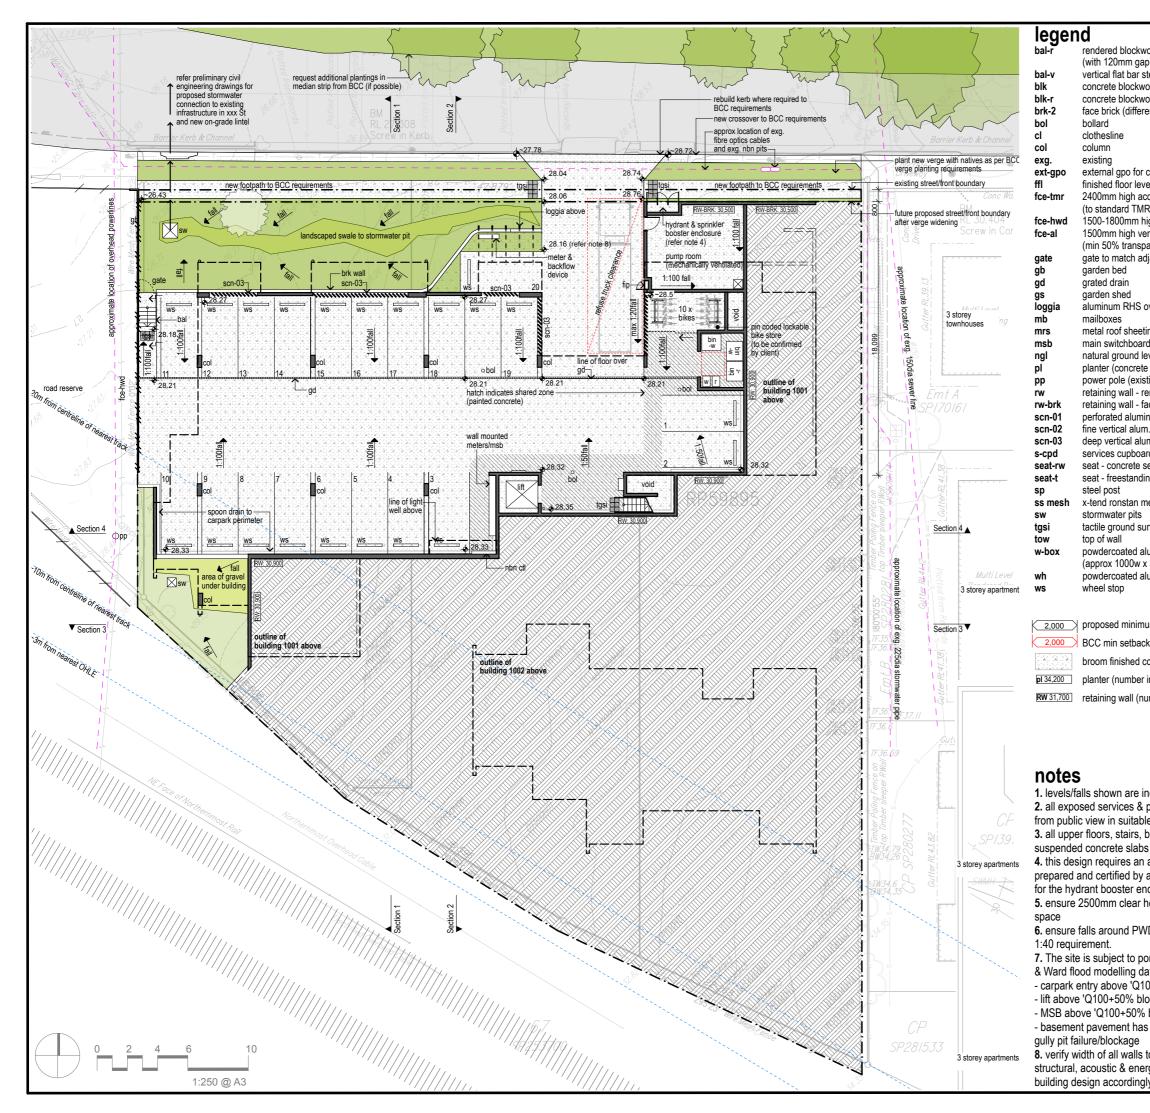


ork balustrade o where it meets wall) teel or aluminium balustrade ork		
ork - rendered & painted ent colour to rw-brk)	AMENDMENTS	
	ISSUE DATE SUBJECT	AUTHORISED
	E 28.06.21 100% SD (F	
	DRAWING INDEX SYSTE FOR BUILDING and ASSET SERVICES	:M S USE ONLY
charging mobility scooters el	CEILING PLANS     CONSTRUCTION DETAILS	MISCELLANEOUS DETAILS     OTHER
oustic fence	ELEVATIONS     EXTERNAL WORKS	PLAY STRUCTURES     ROOF PLANS
R detail) igh timber paling fence	FITOUTS     FLOOR PLANS	SECTIONS SETOUT PLAN
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overhead landscape structure		ieensland
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evel	Housing and	I Public Works
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ace brick (reinforced)		
nium sheet n. rhs batten screen		
m. screen (some at angles)		
rd or riser eat (450mm retaining height)		
ng millboard top on blocks		
esh (engineered for purpose)		
rface indicators		
uminium box for pot plants	SCHEMATIC DESIGN	STAGE
: 300d x 600h) uminium window hood	DRAWING IS INDICATI	VE ONLY -
	CONTRACTOR/CONSU SITE CONDITIONS SH	
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k requirement	LADA	
oncrete	DRAWN	DRAFTING CHECK
indicates top of wall RL)	LADA	
umber indicates top of wall RL)	DESIGN	DESIGN VERIFICATION
	ML	28/06/21
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pipework to be concealed e ducts	PROGRAM	
pridges & landings are		
6		
alternative solution		
a fire engineer closure.	1 x 3 BED UNIT (PLAT	
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	16 x 1 BED UNITS (12	xGULD / 4xGEN)
D carparks do not exceed	BASEMENT /	SITE PLAN
onding. Refer to Bornhorst		
ated May 2020 and ensure:		
00+300mm+20% block' ock'	scale 1:250	A3 SIZE
block'		
s overflow paths to deal with	MASTER SITE NUMBER	CLIENT REFERENCE NUMBER 86664
to comply with NCC,	DRAWING NUMBER	ISSUE SHEET NO
rgy efficiency reqs. Adjust	86664 / SD / A02	
ly.	00004 / SD / AUZ	

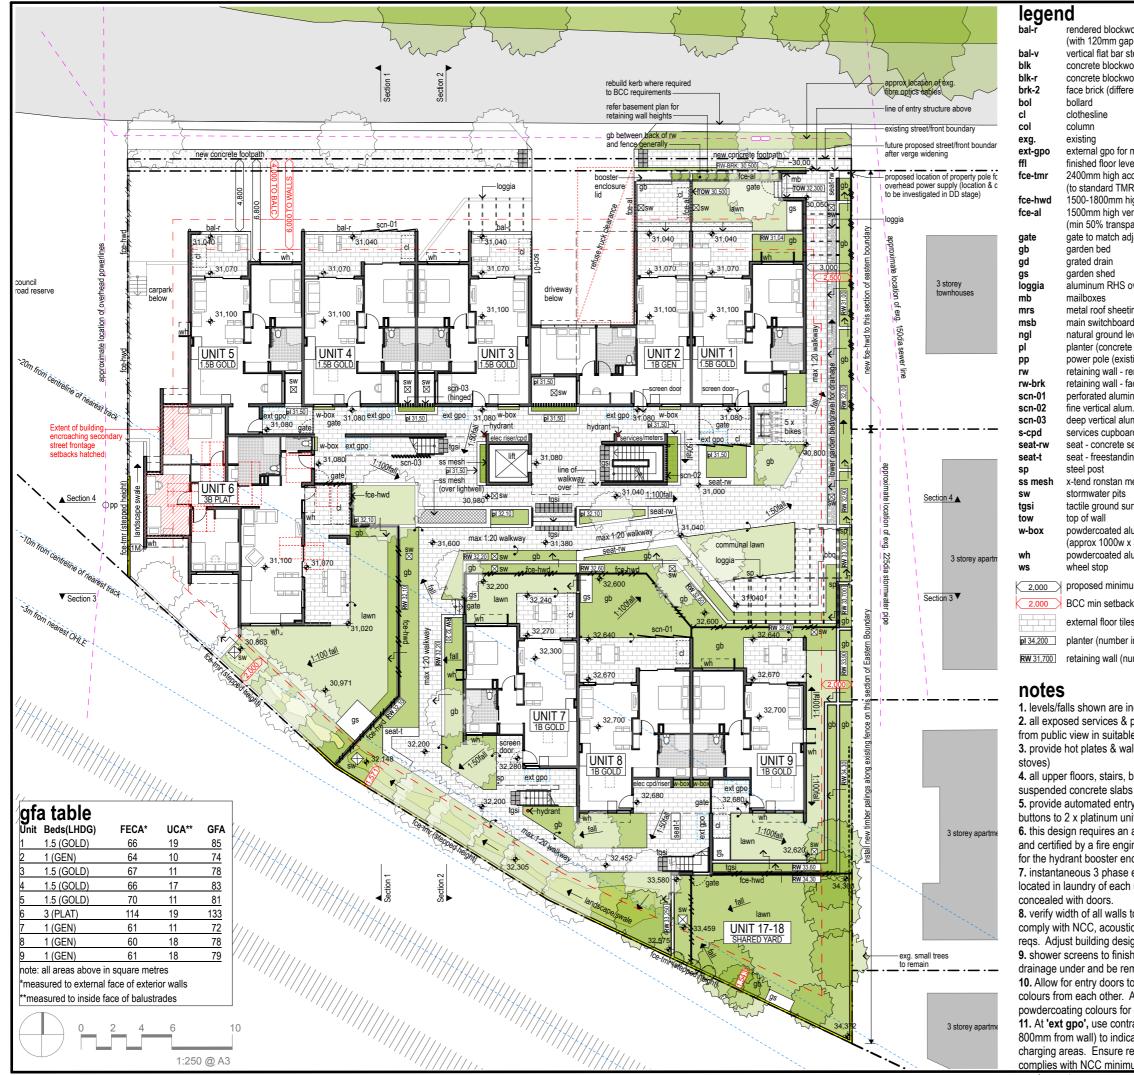


ork balustrade o where it meets wall) teel or aluminium balustrade ork			
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mobility scooter charging	CEILING PLANS	MISCELLANEOUS I	DETAILS
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	DESIGN	DESIGN VERIFICATION	
	ML	28/06/21	
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pipework to be concealed e ducts			
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oridges & landings are			10
y doors with 'push to open'	PROGRAM		
its			
alternative solution prepared	1 x 3 BED UNIT (PLA		
neer	3 x 2 BED UNITS (1xF		) 16
closure. electric hot water heater	x 1 BED UNITS (12xG	OLD / 4xGEN)	
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	GROUND FLO	JOK / 511	
to achieve acoustic rating to	PLAN		
c report & energy efficiency			
gn accordingly. h above floor to allow			
novable at later date.	SCALE	AT	_
b be painted different			
Allow for 2 different MASTER SITE NUMBER CLIENT REFERENCE		CE NUMBER	
doors/windows. asting tile colour (minimum		86664	
ate mobility scooter	DRAWING NUMBER	ISSUE	SHEET NO
emaining walkway width	86664 / SD / A02	2.02	
um path of travel			1

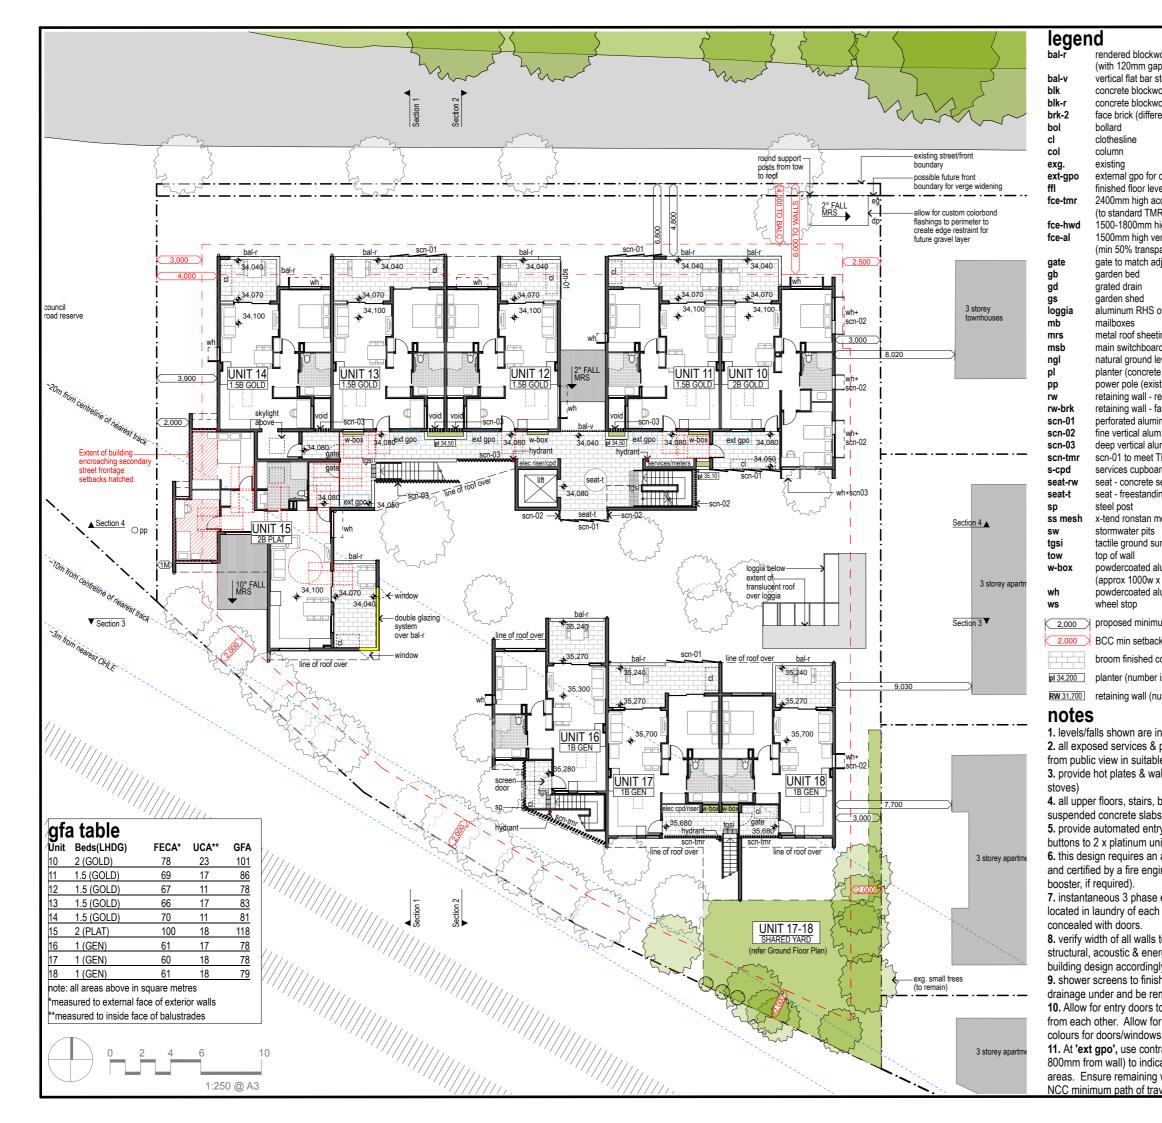

ork balustrade		
p where it meets wall) teel or aluminium balustrade		
ork		
ork - rendered & painted ent colour to rw-brk)	AMENDMENTS	
,	ISSUE DATE SUBJECT	
	E 28.06.21 100% SD (F DRAWING INDEX SYSTE	
charging mobility scooters	FOR BUILDING and ASSET SERVICES	S USE ONLY
el	CEILING PLANS	OTHER     PLAY STRUCTURES
coustic fence R detail)	ELEVATIONS     EXTERNAL WORKS     FITOUTS	ROOF PLANS     SECTIONS
igh timber paling fence ertical rhs aluminium fence	FLOOR PLANS FURNITURE & EQUIPMENT	SETOUT PLAN
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MR requirements		
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rface indicators		
luminium box for pot plants	SCHEMATIC DESIGN S	
(300d x 600h) Iuminium window hood	DRAWING IS INDICATI	
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um setback	SURVEY AND ACTUAL	
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umber indicates top of wall RL)	DESIGN	DESIGN VERIFICATION
	ML	28/06/21
ndicative only. pipework to be concealed	DISCIPLINE TEAM LEADER	DATE
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alternative solution prepared	1 x 3 BED UNIT (PLAT	
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electric hot water heater	X 1 BED UNITS (12XG	OLD / 4XGEIN)
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to comply with NCC,		
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movable at later date.	SCALE	
o be painted different colours r 2 different powdercoating	1:250	A3 SIZE
S.	MASTER SITE NUMBER	CLIENT REFERENCE NUMBER 86664
rasting tile colour (minimum	DRAWING NUMBER	ISSUE SHEET NO
ate mobility scooter charging walkway width complies with	86664 / SD / A02	03
vel requirement.		

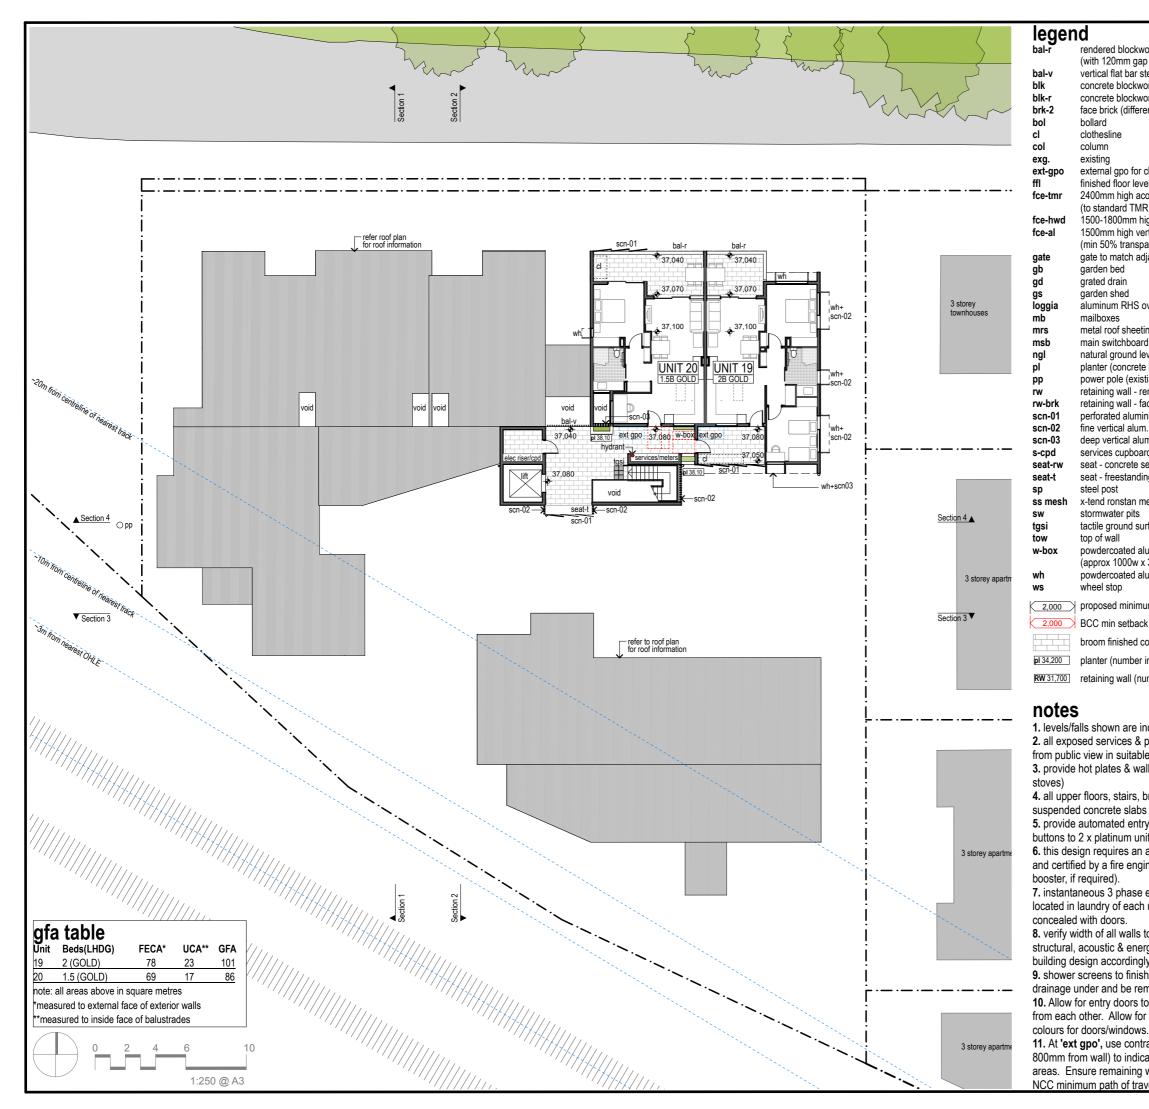

ork balustrade o where it meets wall) teel or aluminium balustrade ork ork - rendered & painted ent colour to rw-brk)	AMENDMENTS ISSUE DATE SUBJECT E 28.06.21 100% SD (F DRAWING INDEX SYSTE	
charging mobility scooters el coustic fence R detail) igh timber paling fence rrtical rhs aluminium fence arency) jjacent fce/creen	FOR BUILDING and ASSET SERVICES CEILING PLANS CONSTRUCTION DETAILS ELEVATIONS EXTERNAL WORKS FITOUTS FILOOR PLANS FURNITURE & EQUIPMENT HYDRAULICS MASTER PLAN	SUSE ONLY         MISCELLANEOUS DETAILS         OTHER         PLAY STRUCTURES         ROOF PLANS         SECTIONS         SETOUT PLAN         STE PLAN         STANDARDS
overhead landscape structure ing in colorbond d evel a block, rendered)	Department of	i <b>eensland</b> overnment I Public Works
ting) endered block ace brick (reinforced) nium sheet n. rhs batten screen m. screen (some at angles) rd or riser weat (450mm retaining height)		
ng millboard top on blocks		
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uminium box for pot plants 300d x 600h) uminium window hood um setback	SCHEMATIC DESIGN STAGE DRAWING IS INDICATIVE ONLY - CONTRACTOR/CONSULTANT TO VERIFY SITE CONDITIONS SHOWN ON THIS DRAWING WITH CONTOUR AND DETAIL	
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oncrete indicates top of wall RL)		DRAFTING CHECK
umber indicates top of wall RL)	DRAWN LADA DESIGN	DESIGN VERIFICATION
ndicative only. pipework to be concealed e ducts	ML DISCIPLINE TEAM LEADER	28/06/21 date
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bridges & landings are	19/20 SOCIAI	L HOUSING
s y doors with 'push to open' 	PROGRAM	
its alternative solution prepared ineer (to avoid shield wall for	1 x 3 BED UNIT (PLAT 3 x 2 BED UNITS (1xF x 1 BED UNITS (12xG	PLAT / 2xGOLD) 16
electric hot water heater unit. All laundries to be	ctric hot water heater	
to comply with NCC, rgy efficiency reqs. Adjust ly. h above floor to allow		
movable at later date. o be painted different colours	scale 1:250	A3 SIZE
r 2 different powdercoating	MASTER SITE NUMBER	CLIENT REFERENCE NUMBER
rasting tile colour (minimum	DRAWING NUMBER	ISSUE SHEET NO
ate mobility scooter charging walkway width complies with vel requirement.		

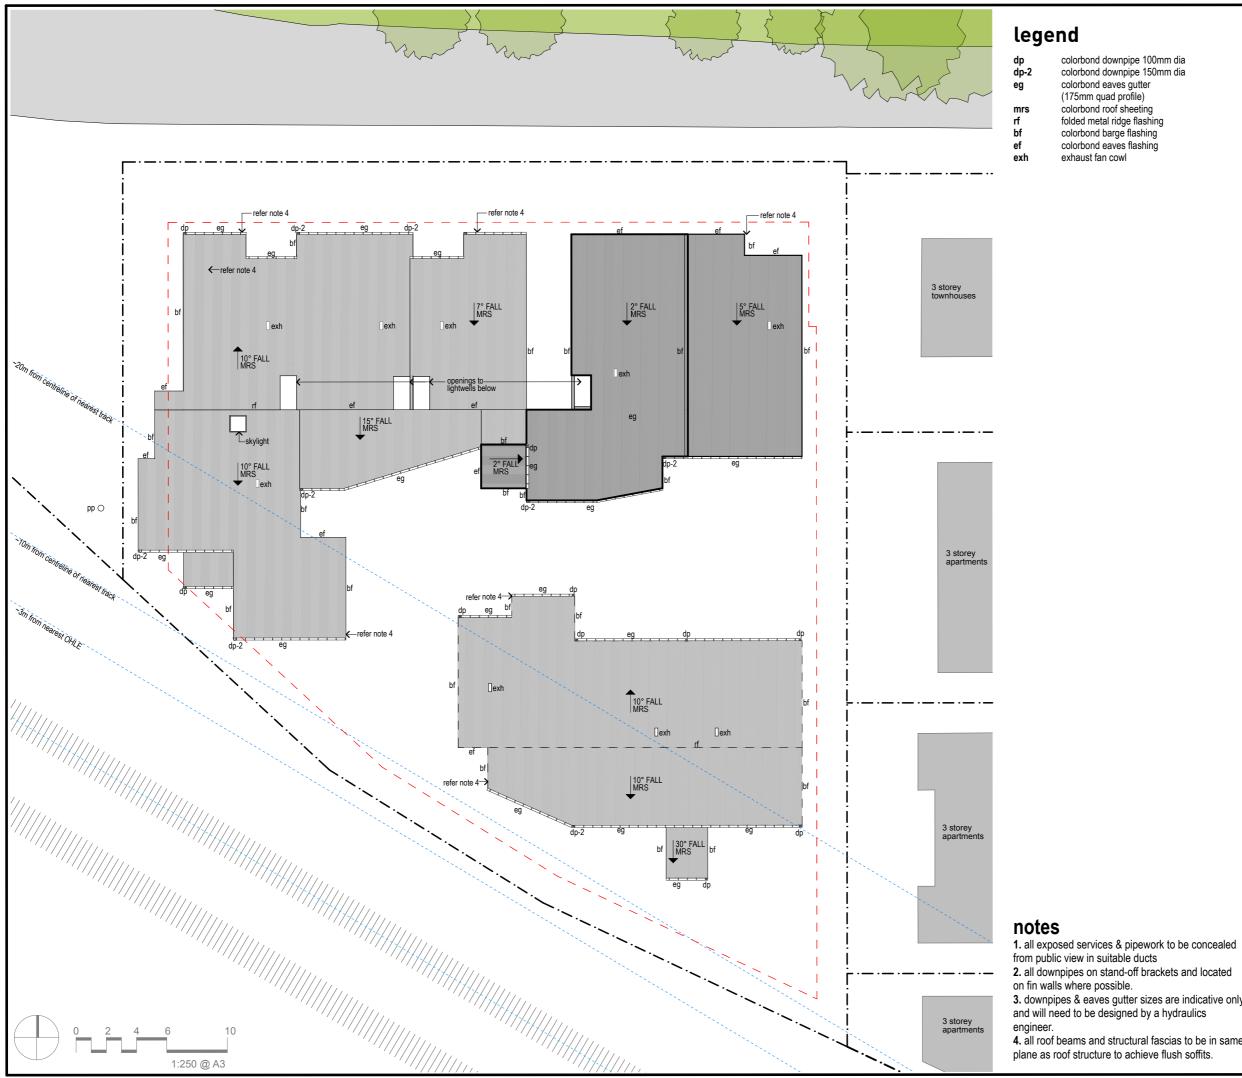

colorbond downpi colorbond downpi colorbond eaves g (175mm quad pro colorbond roof sh folded metal ridge colorbond barge fl colorbond eaves fl

pipe 100mm dia
pipe 150mm dia
gutter
ofile)
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DRAWI	NG NUME	BER		20004	ISSUE	SHEET
000	6A 🖊	SD / A	<u>12 n</u>	5		
i xnn						

4. all roof beams and structural fascias to be in same plane as roof structure to achieve flush soffits.

## leaend

			$\sim$	
broom cupboard	HW	hot water	<b>•</b> •	adjacent surfaces flush
cupboard (under bench)	LIN	linen cupboard		
cupboard (overhead)	М	microwave alcove under bench	30	step in finished floor level (30mm)
clothes line	MPR		-	,
tiles	NBN/SW			
carpet				
drawers	•••			
dryer				
fridge				
floor tiles - wet area	SFU			
floor tiles - external	SFO	open shelves (overhead)		
grab rail	VF	vinyl flooring		
hot plate	WM	washing machine		
	cupboard (under bench) cupboard (overhead) clothes line tiles carpet drawers dryer fridge floor tiles - wet area floor tiles - external grab rail	broom cupboard HW cupboard (under bench) LIN cupboard (overhead) M clothes line MPR tiles NBN/SW carpet OV drawers P dryer R fridge SF floor tiles - wet area SFU floor tiles - external SFO grab rail VF	broom cupboard     HW     hot water       cupboard (under bench)     LIN     linen cupboard       cupboard (overhead)     M     microwave alcove under bench       clothes line     MPR     Multi Purpose Room       tiles     NBN/SW     NBN / switch board       carpet     OV     oven       drawers     P     pantry       dridge     SF     shelves (general)       floor tiles - wet area     SFU     open shelves (under bench)       floor tiles - external     SFO     open shelves (overhead)       grab rail     VF     vinyl flooring	broom cupboard cupboard (under bench) cupboard (overhead) M microwave alcove under bench clothes line MPR Multi Purpose Room tiles NBN/SW NBN / switch board carpet OV oven drawers P pantry dryer R robe fridge SF shelves (general) floor tiles - wet area SFU open shelves (under bench) floor tiles - external SFO open shelves (overhead) grab rail VF vinyl flooring

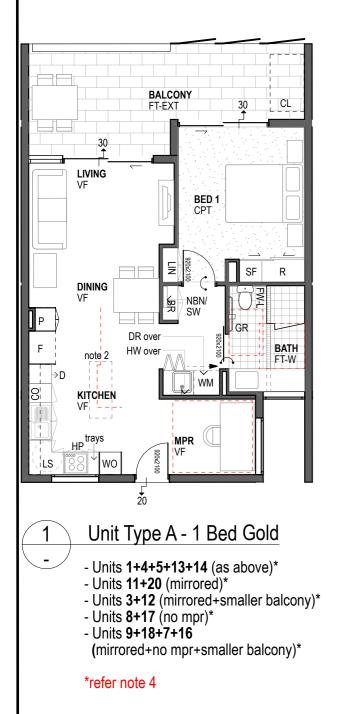
## notes

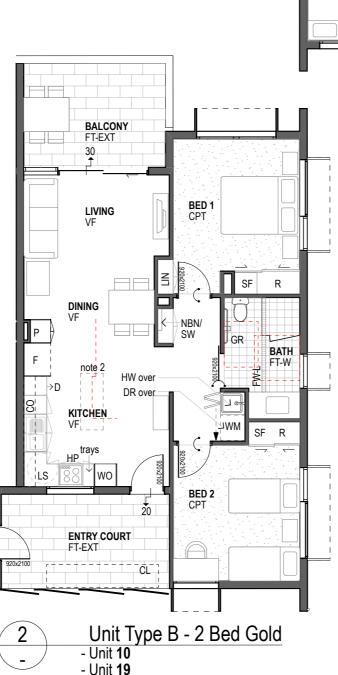
1. Shower screen to allow drainage under and be removable at later date

2. Layout allows tenant with no accessibility requirement to introduce a freestanding 1500x600 island bench to increase & personalise kitchen space.

3. Chairs here are within 1500mm clearance, however table can be moved in front of glass door to comply if needed. 4. All of these units are based on unit type A, each with their own minor variances. Refer to 1:250 floor plans & elevations for details of these variances.

5. Laundry in Unit Type A in building 1001 are 2100mm high only to allow ventilation over the top and to make the units feel more spacious.





SF

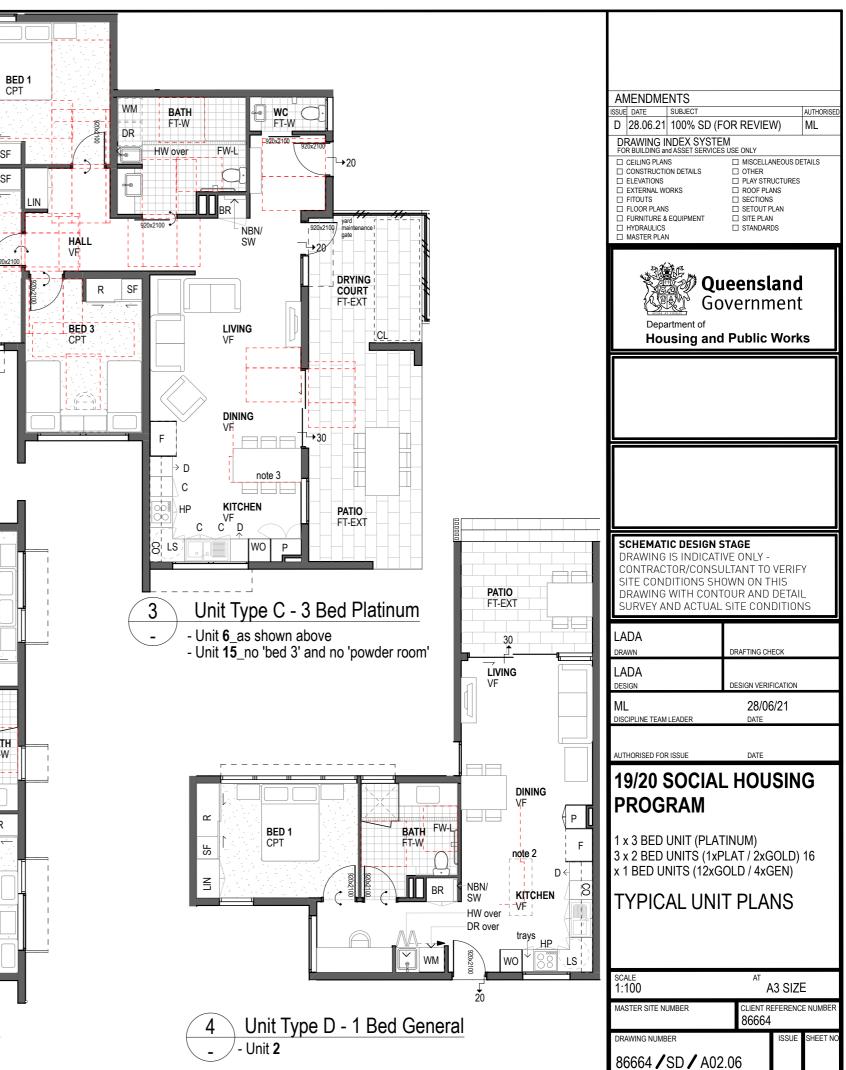
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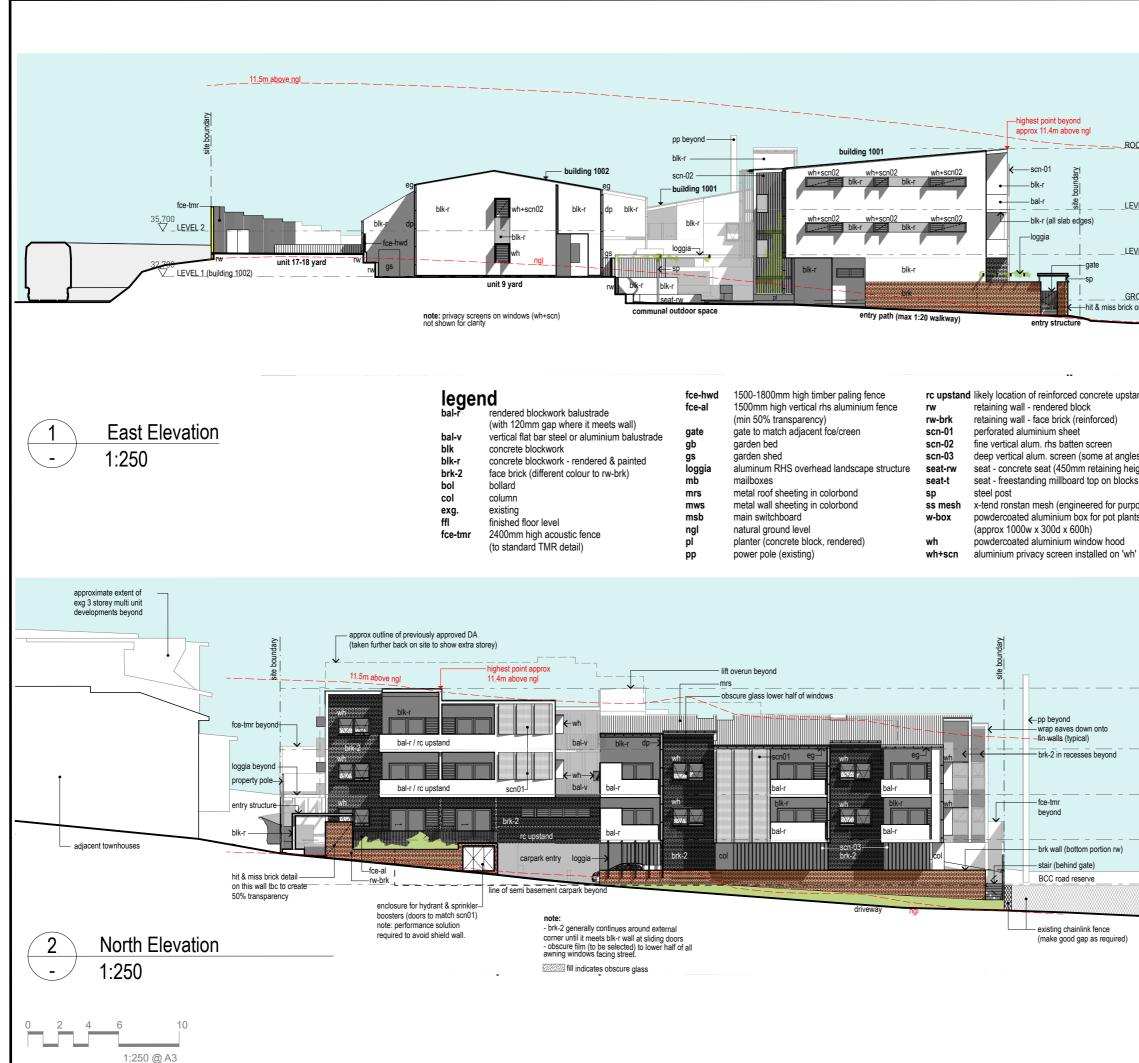
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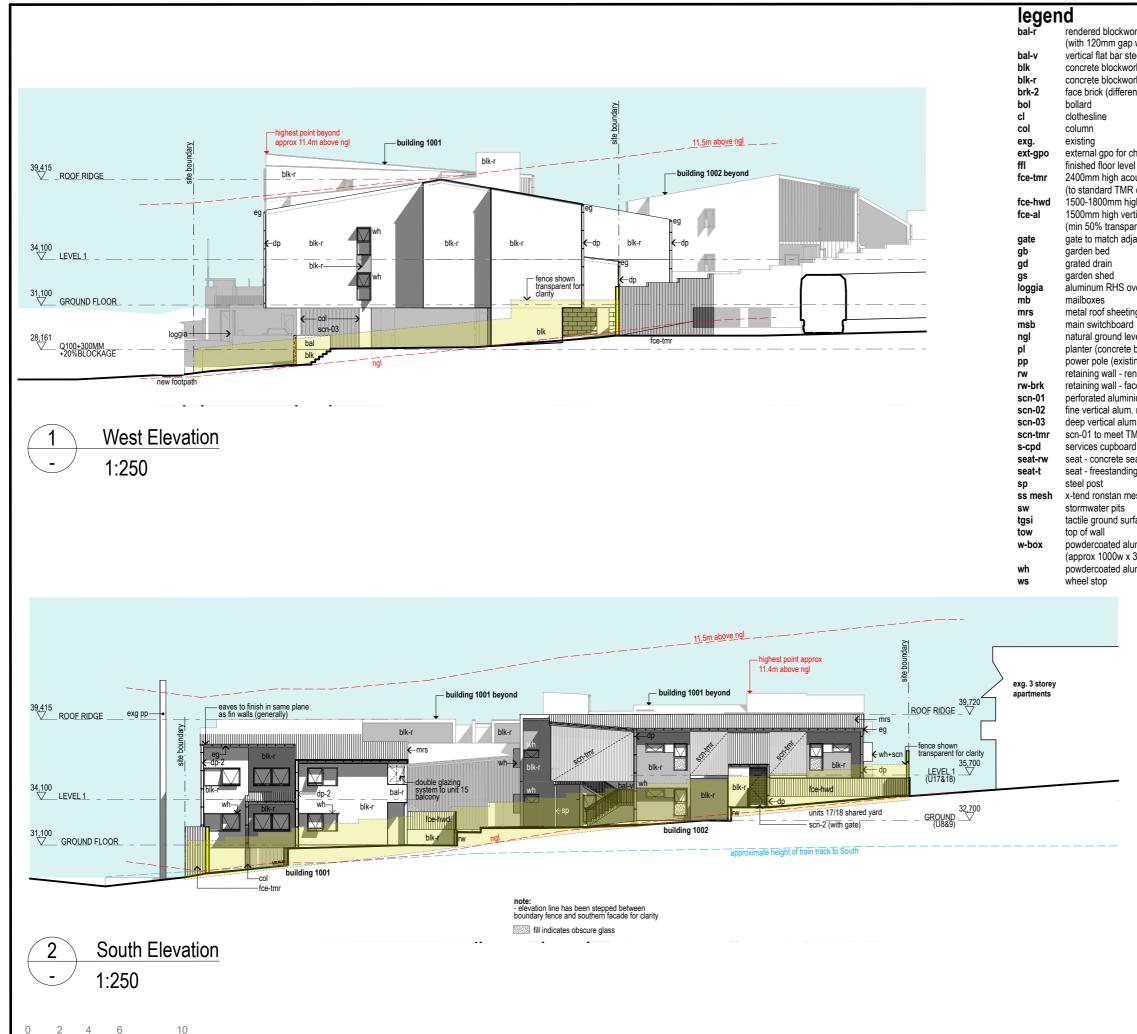
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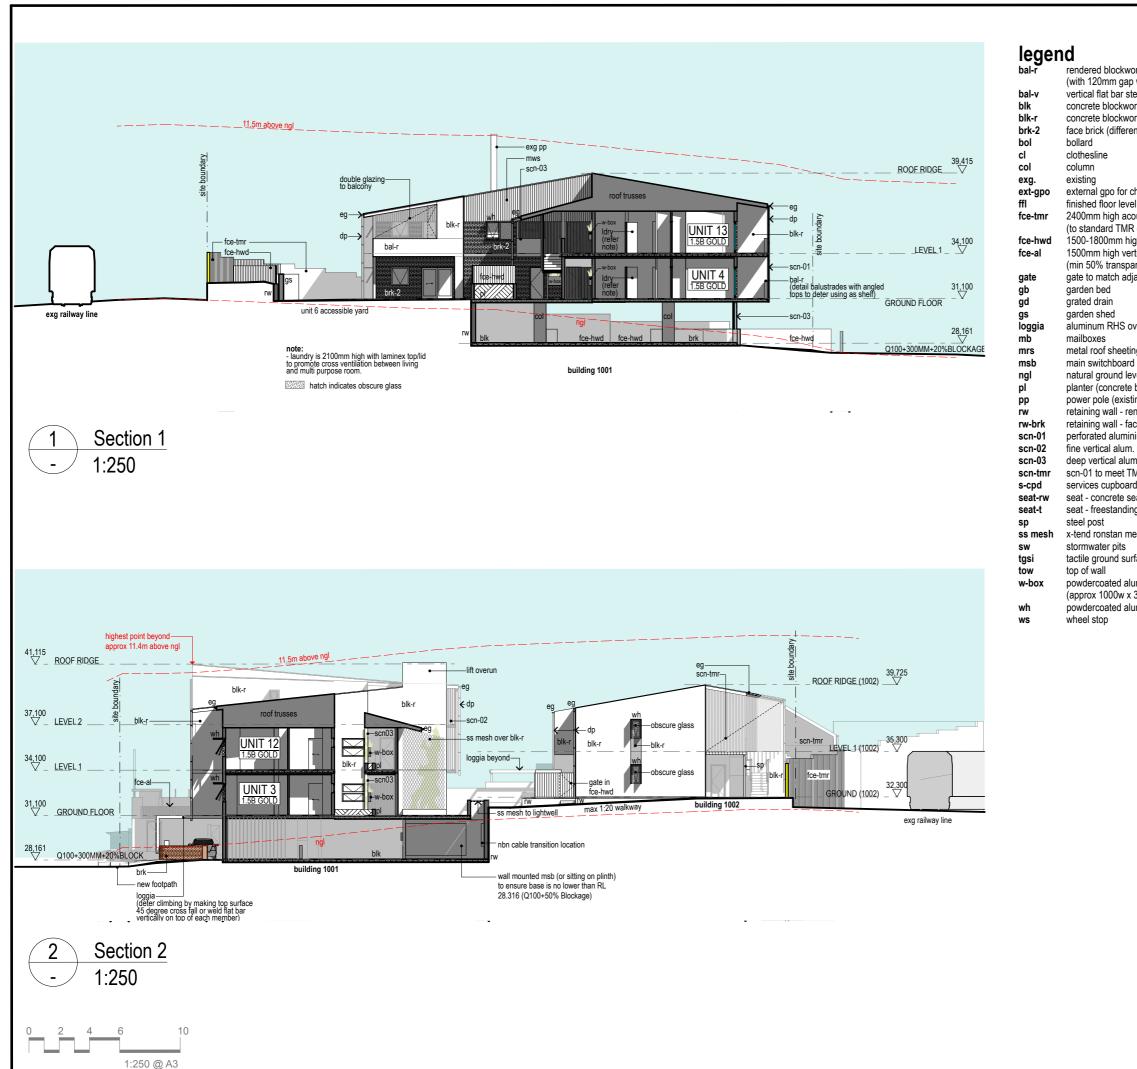


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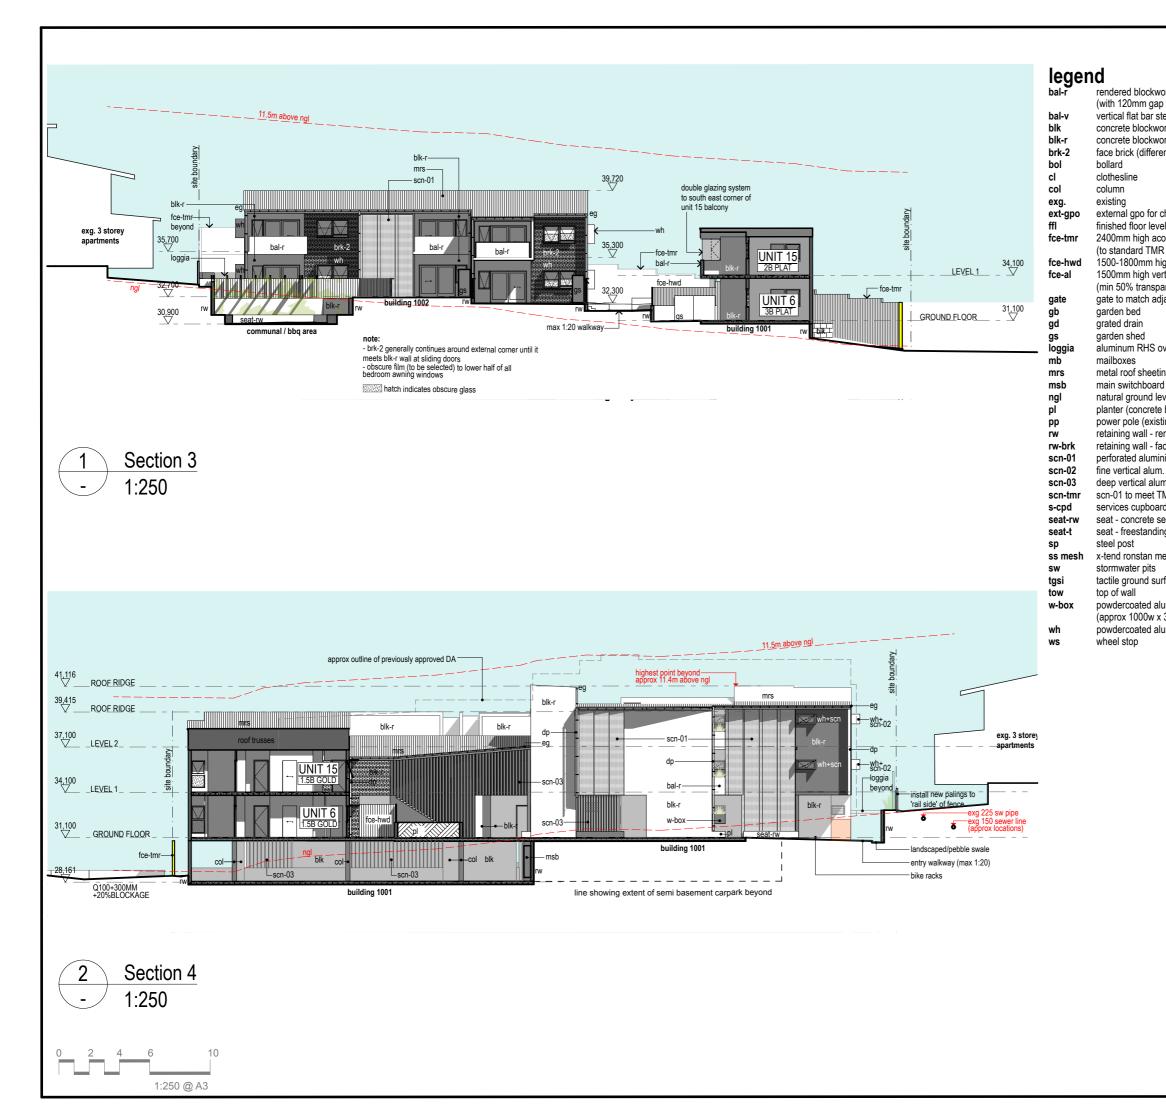
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